

		NERS	STC	NE -	- BEA	CON		Pack Issue		
	Cell Name:								А	_
	CORNERSTONE	TEF		١	VF	Site Addres	ss	_		
	-	-			1			- - - -		
Drawing Name	Drawing No		Date		Date Revision	Date	Date	Date	Date	Date
Site Location Maps	100		ist iss A	ue	Revision	Revision	Revision	Revision	Revision	Revision
Lease Drawing	101		A	\dashv						+
Existing Site Plan	200		A	\dashv						+
Proposed Site Plan	201		A	\dashv						+
Existing Site Elevation	300		A							+
Proposed Site Elevation	301		A	\dashv						+
Antenna Plan	400		A	+					1	+
Equipment Layout	400		A	+					1	+
Occupational ICNIRP Exclusion Zone Plan			A	\pm						+
Occupational ICNIRP Exclusion Zone Flan			A	\dashv					1	+
Public ICNIRP Exclusion Zone Plan	404		A						1	+
Public ICNIRP Exclusion Zone Elevation	404		A						1	+
Existing Antenna Schedule	500		A							+
Proposed Antenna Schedule	501		A	+						+
R.F. System Schematic	502		A	\dashv		A				+
Equipment Schedule	503		A	\dashv	-	_		- \		+
Equipment Senedale	303									+
				╅						+
				+	_					+
				+						+
}			-	\dashv						+
				\dashv						+
				\dashv	-					+
				\dashv						+
				\dashv						+
			-	+						+
				\dashv						+
				\dashv						+
				+						+
				+						+
				+						+
				\dashv						+
				+			-			+
Company	Name		Issued	\dagger		<u> </u>		<u> </u>	<u> </u>	
Acquisition/Planning	_		√	十						
TEF Radio Planner	_		∨ ✓	\dashv						
Principal Designer (ICS)	TEF Design	Inbox	✓	+						+
r moipur bosigner (100)	. L. 500igii		 	\dashv				1		+
				\dashv						1
				\dashv						
			 	+			 	1		+
1										

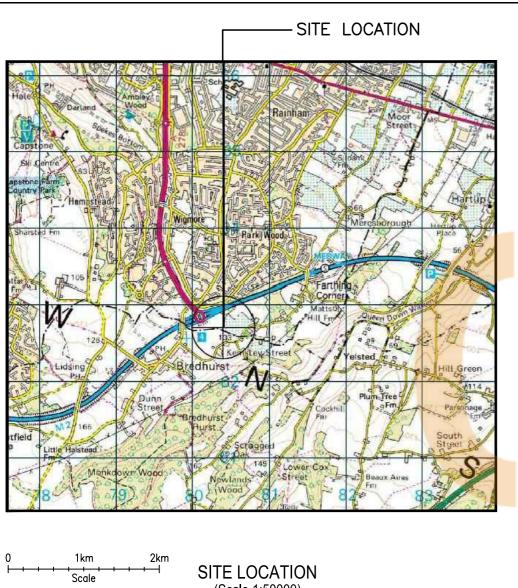

(Scale 1:50000)

Ordnance Survey map extract based upon Landranger map series with the permission of the controller of Her Majesty's Stationery Office Licence No. ES100017753 Crown copyright.

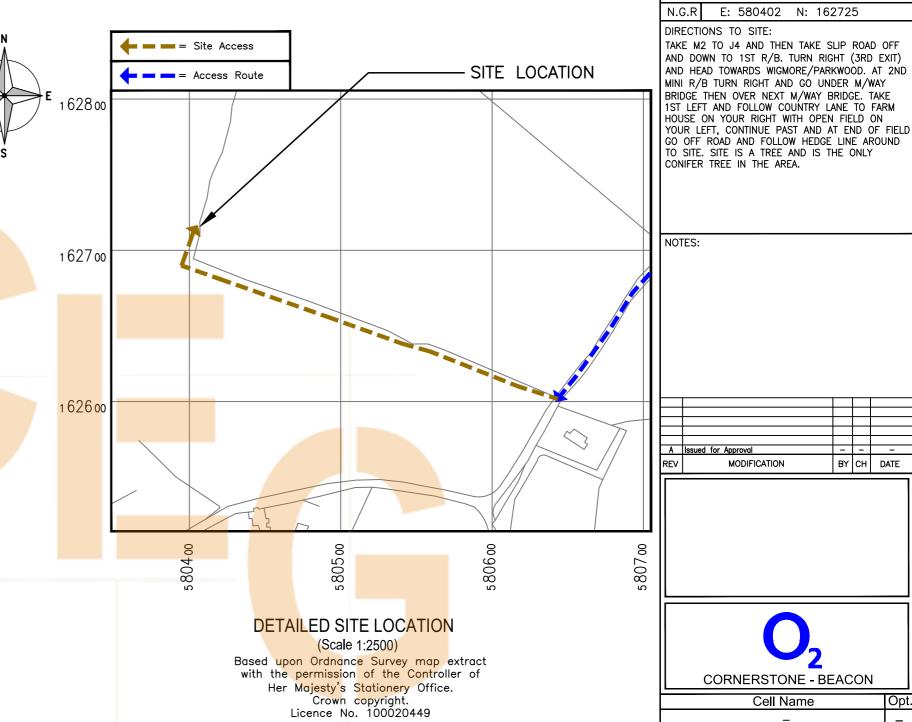



100 50 0 100 150 200 ORIGINAL SCALE AT A3 - 1:2500 ALL DIMENSIONS IN METRES

CORNERSTONE - BEACON Cell Name

MODIFICATION

BY CH

DATE

Opt.

Dwg Rev:

ALL DIMENSIONS ARE IN mm UNLESS NOTED OTHERWISE

E: 580402 N: 162725

Cell ID No CORNERSTONE

Site Address / Contact Details


Drawing Title:


SITE LOCATION MAPS


Purpose of issue **PLANNING** Drawing Numbe 100


Original Sheet Size Surveyed By:


The drawings comply with TEF & Vodafone Standard ICNIRP guidelines. Designed in accordance with CORNERSTONE document: SDN0008 4.0

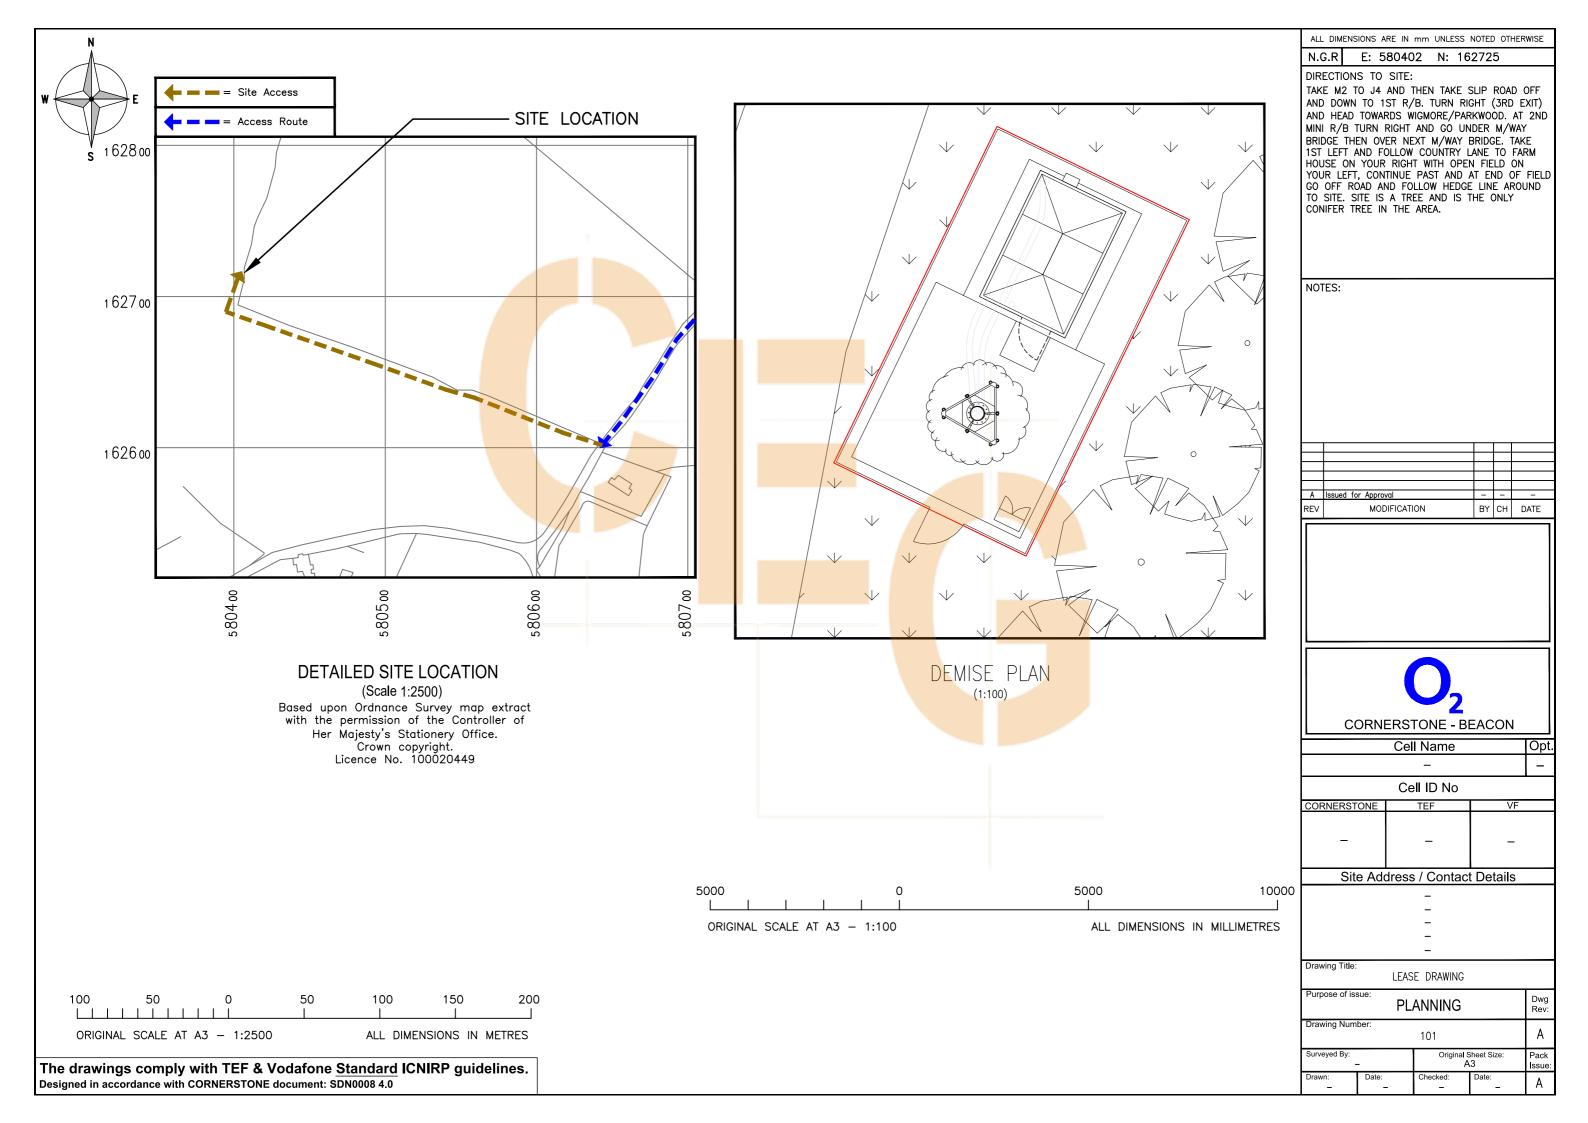


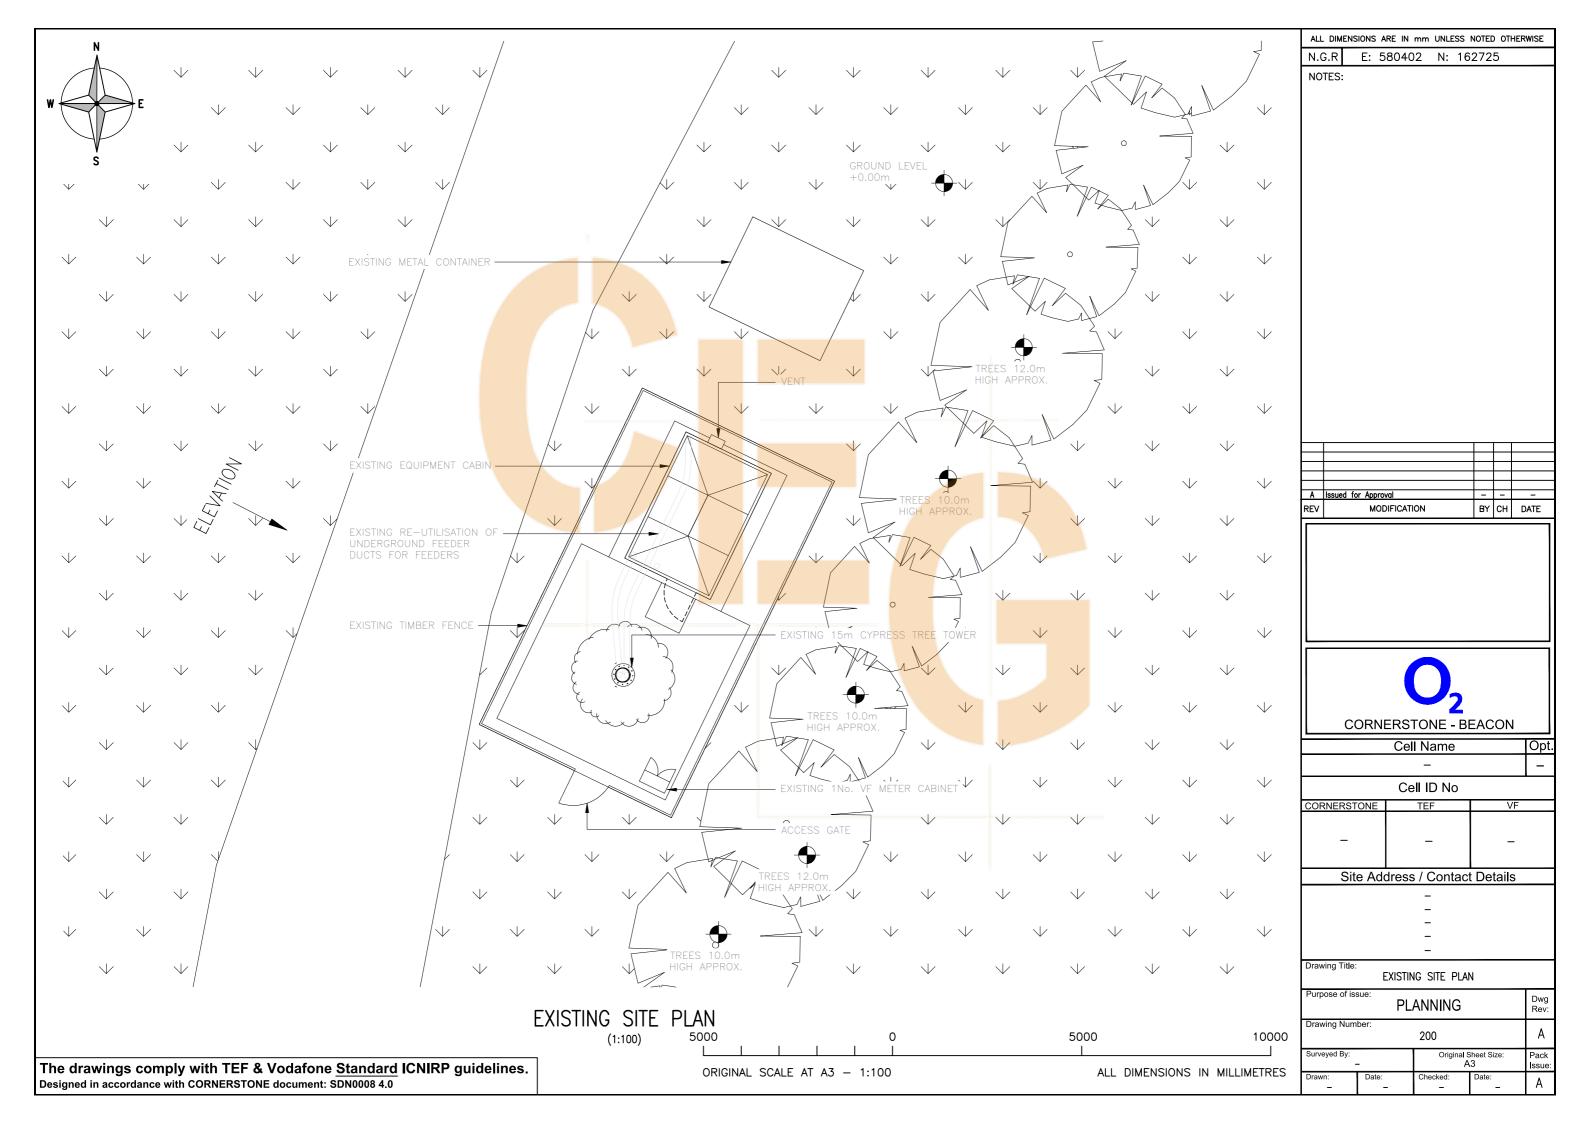


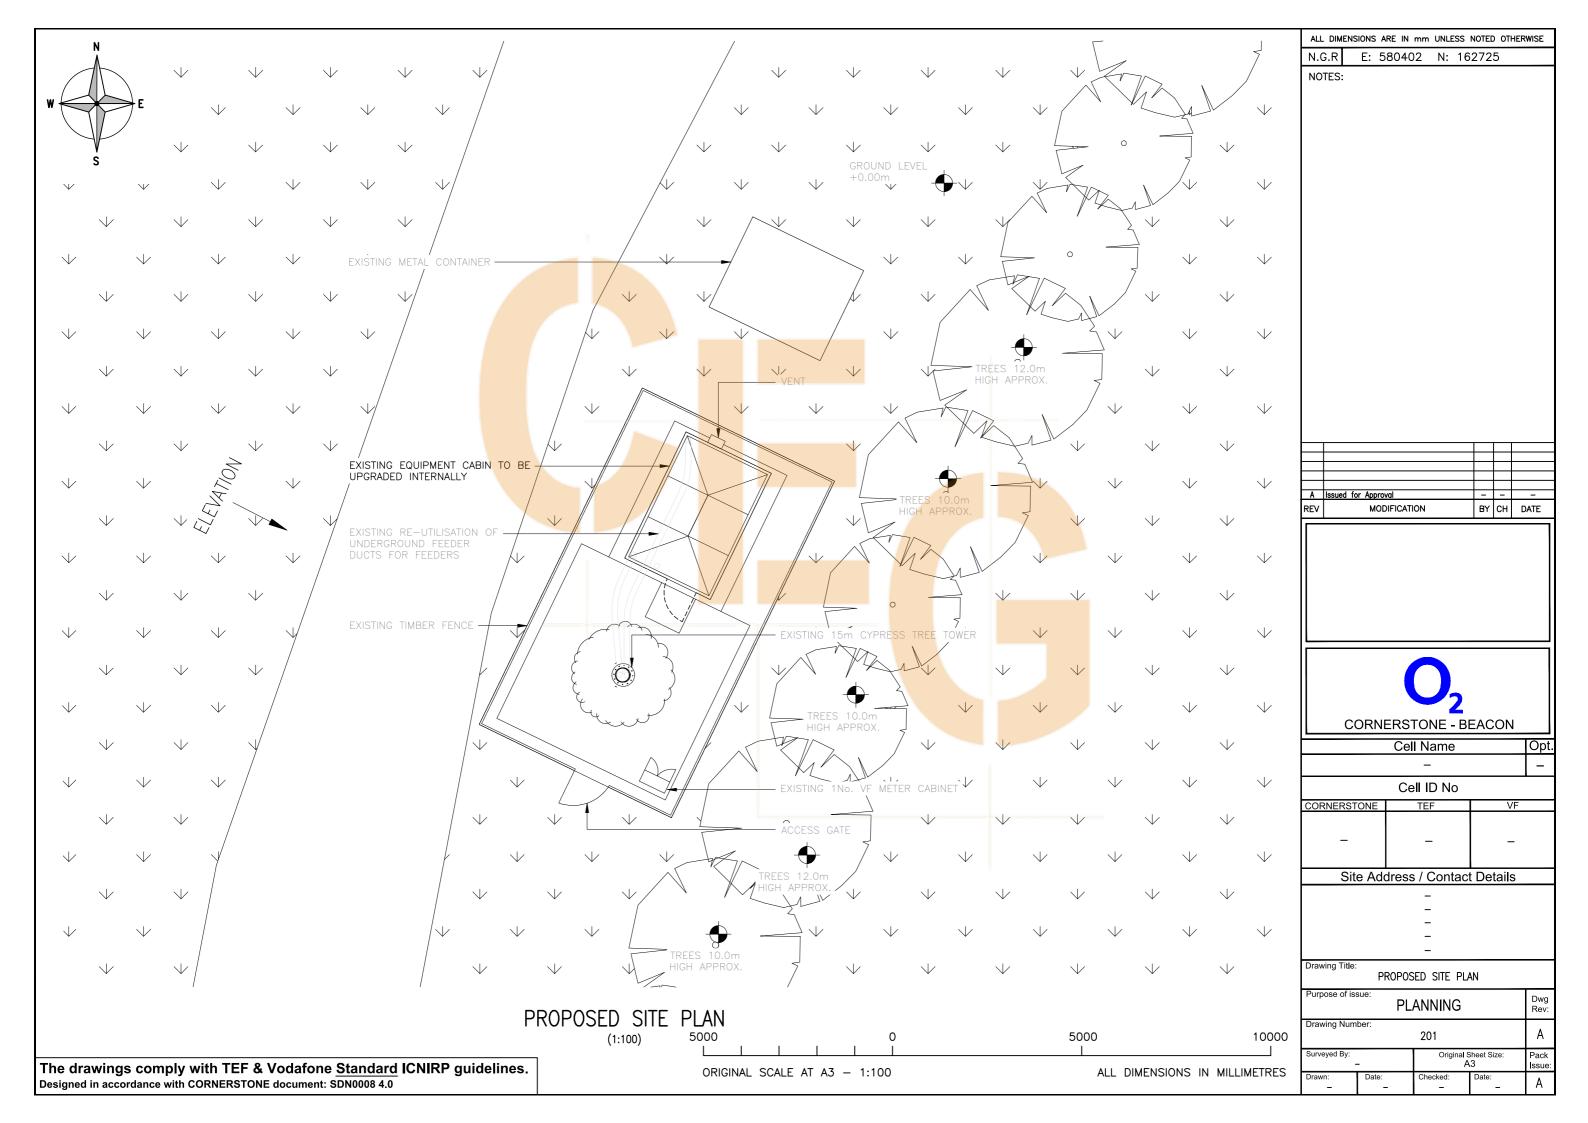


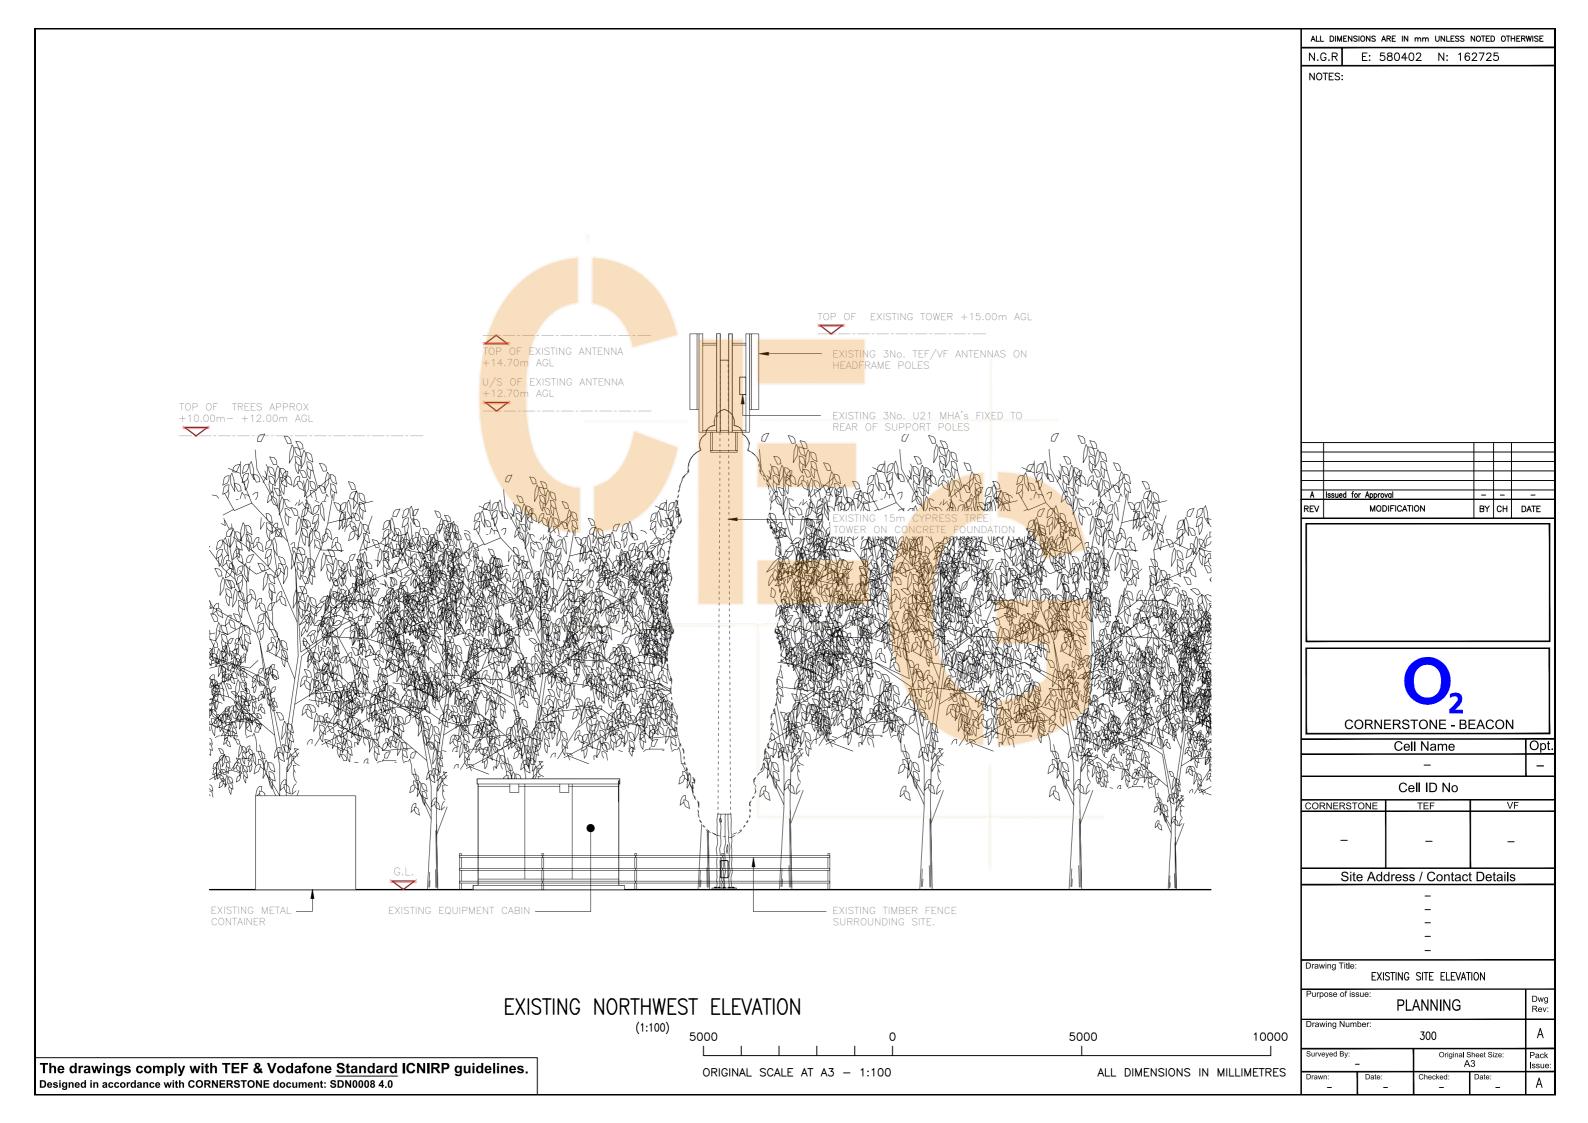


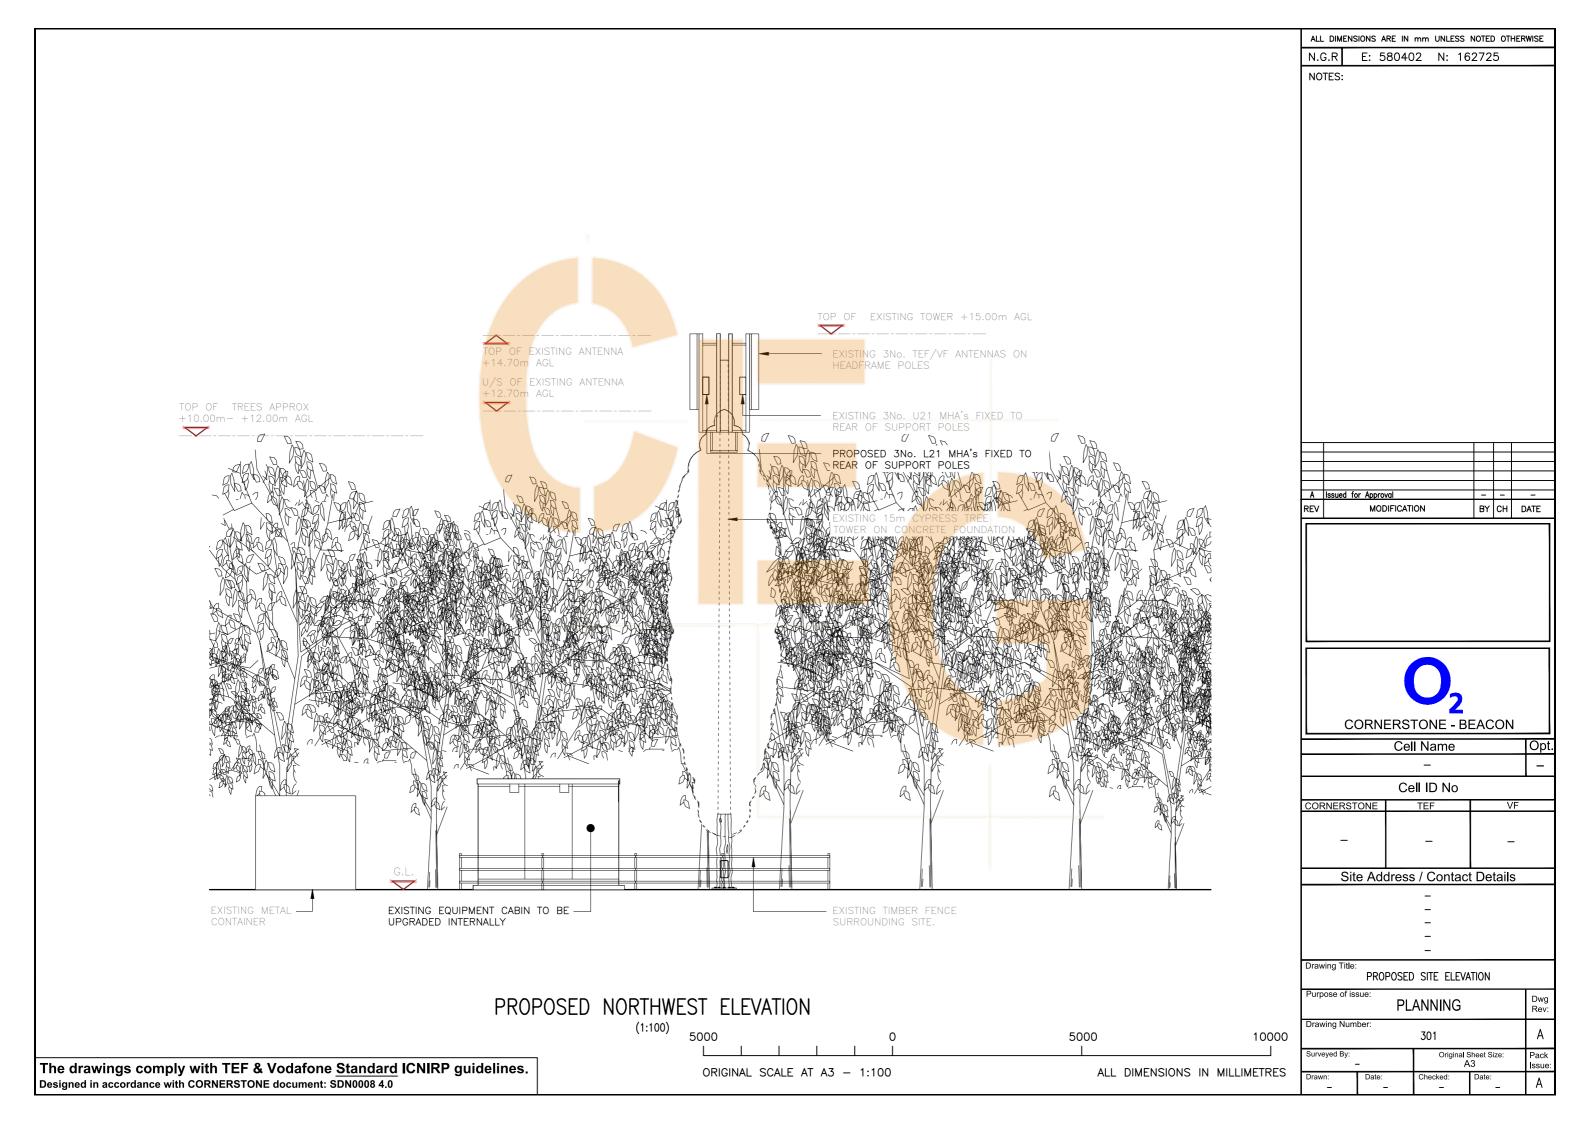


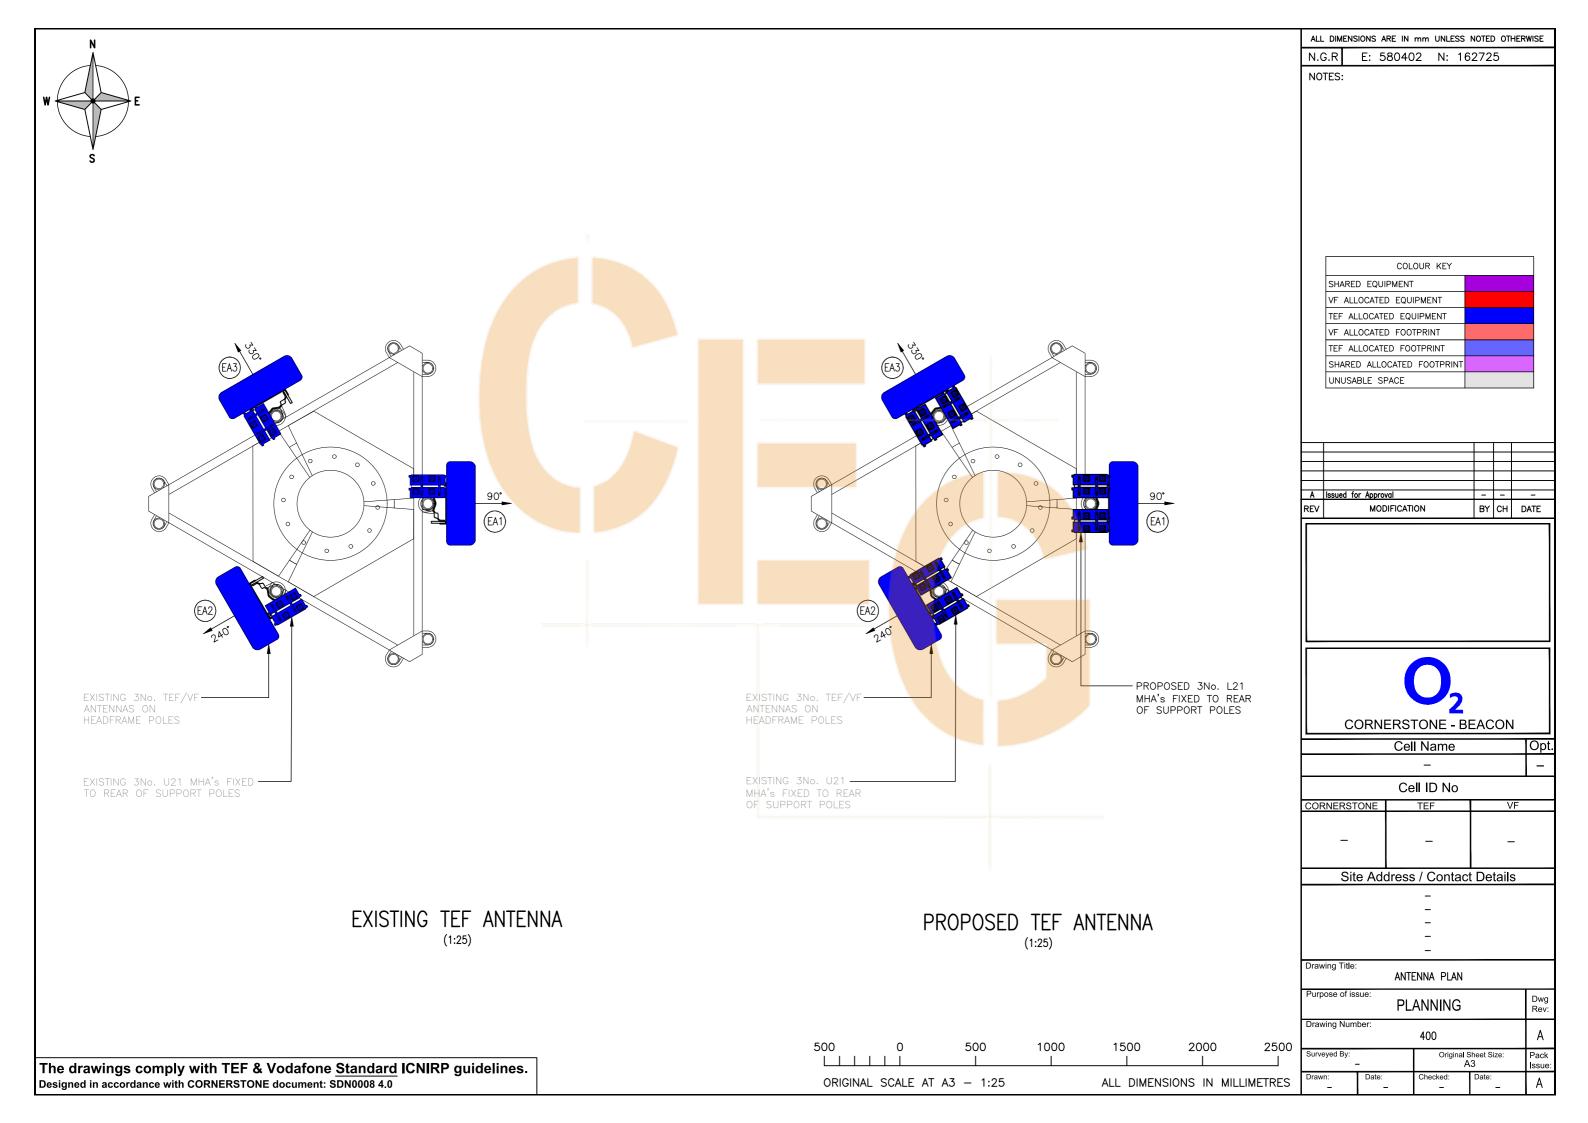


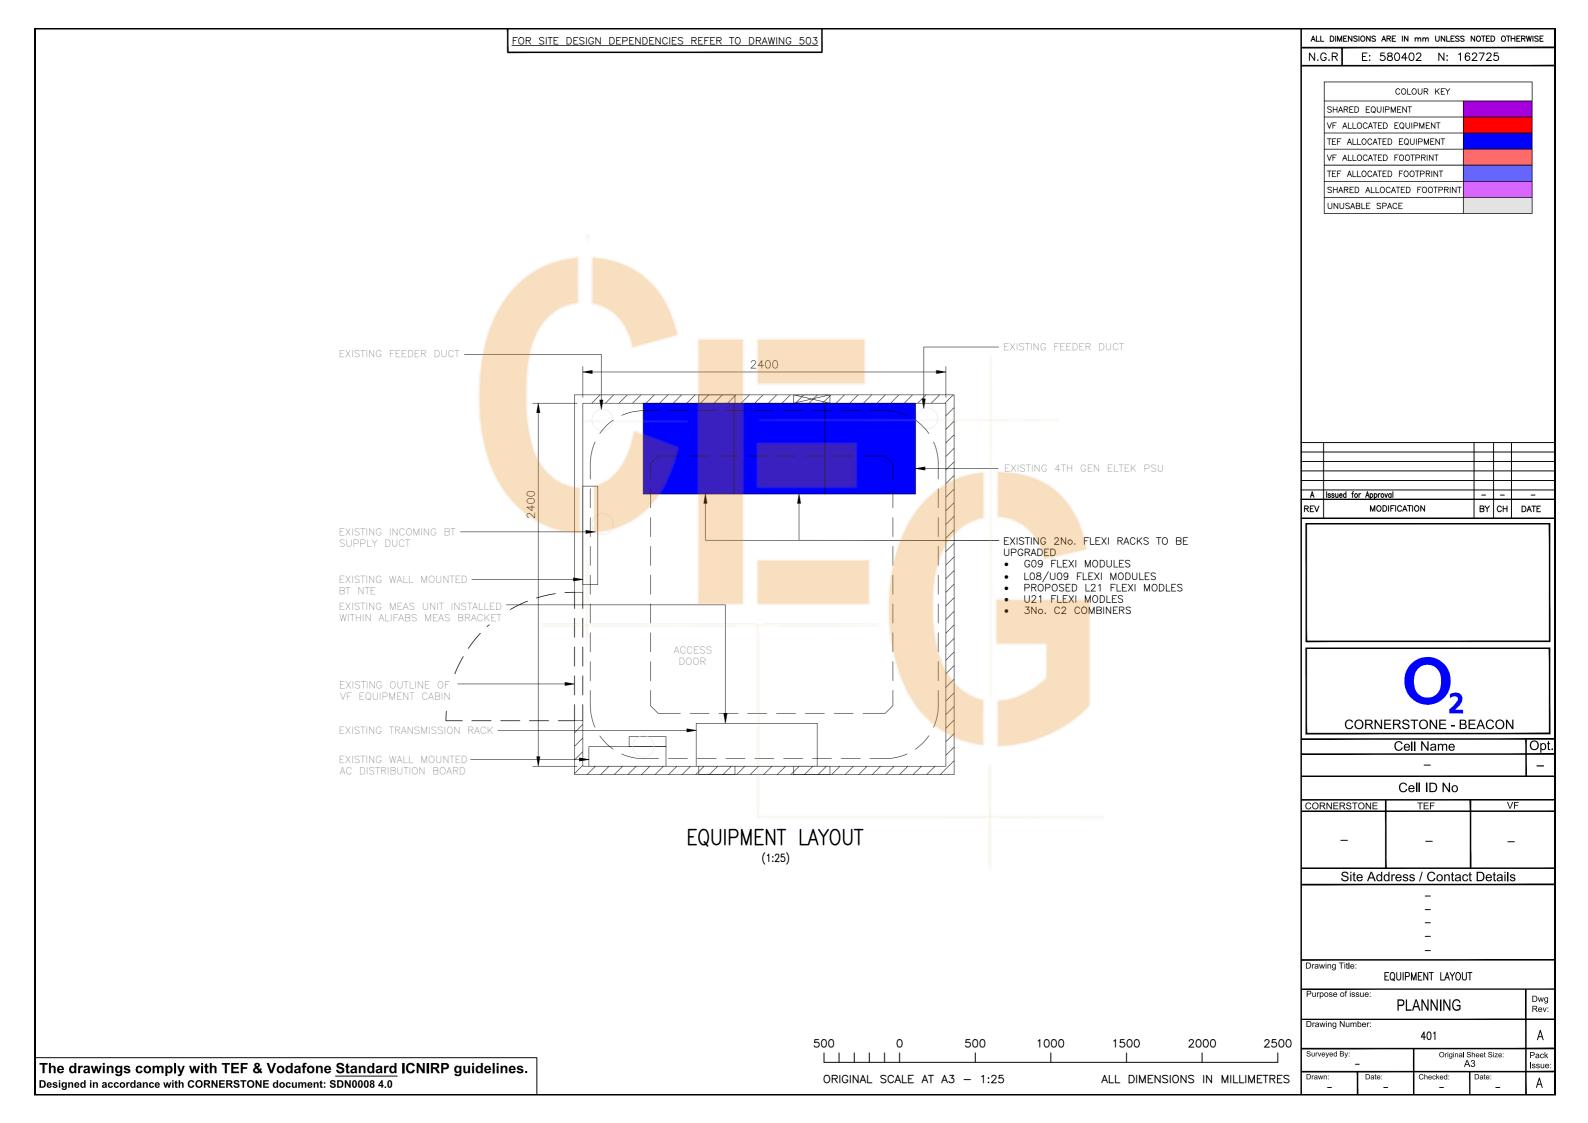

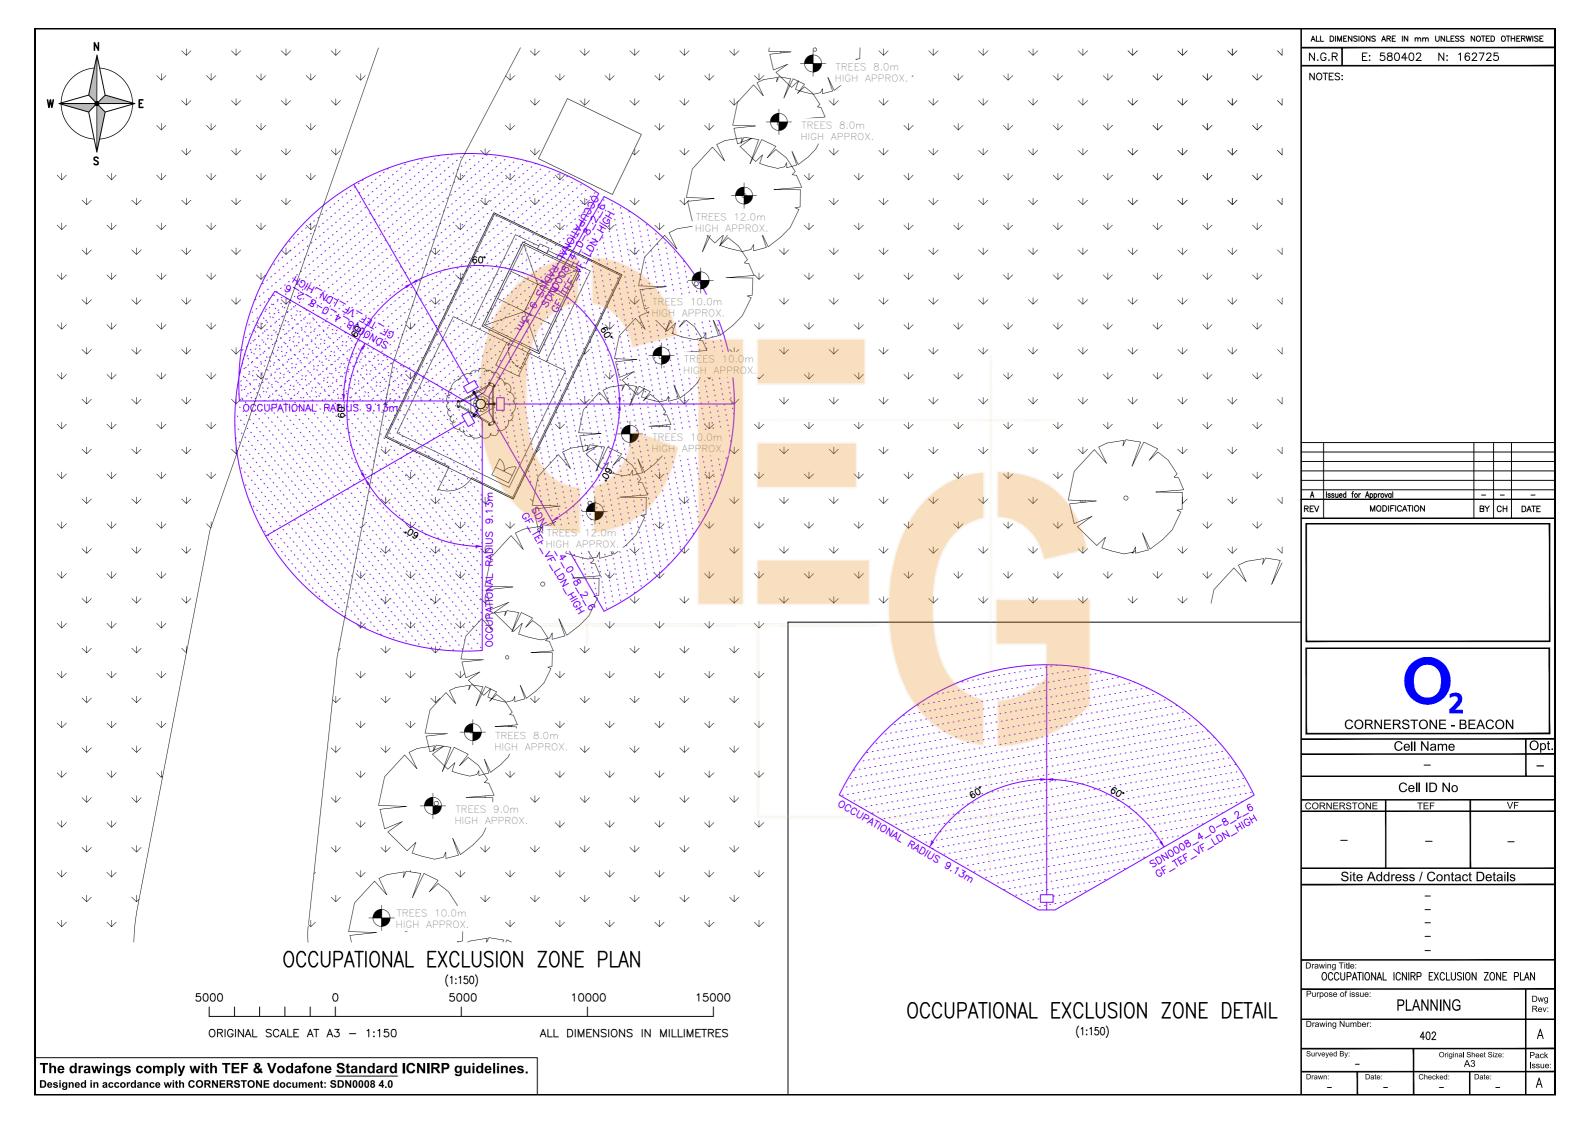


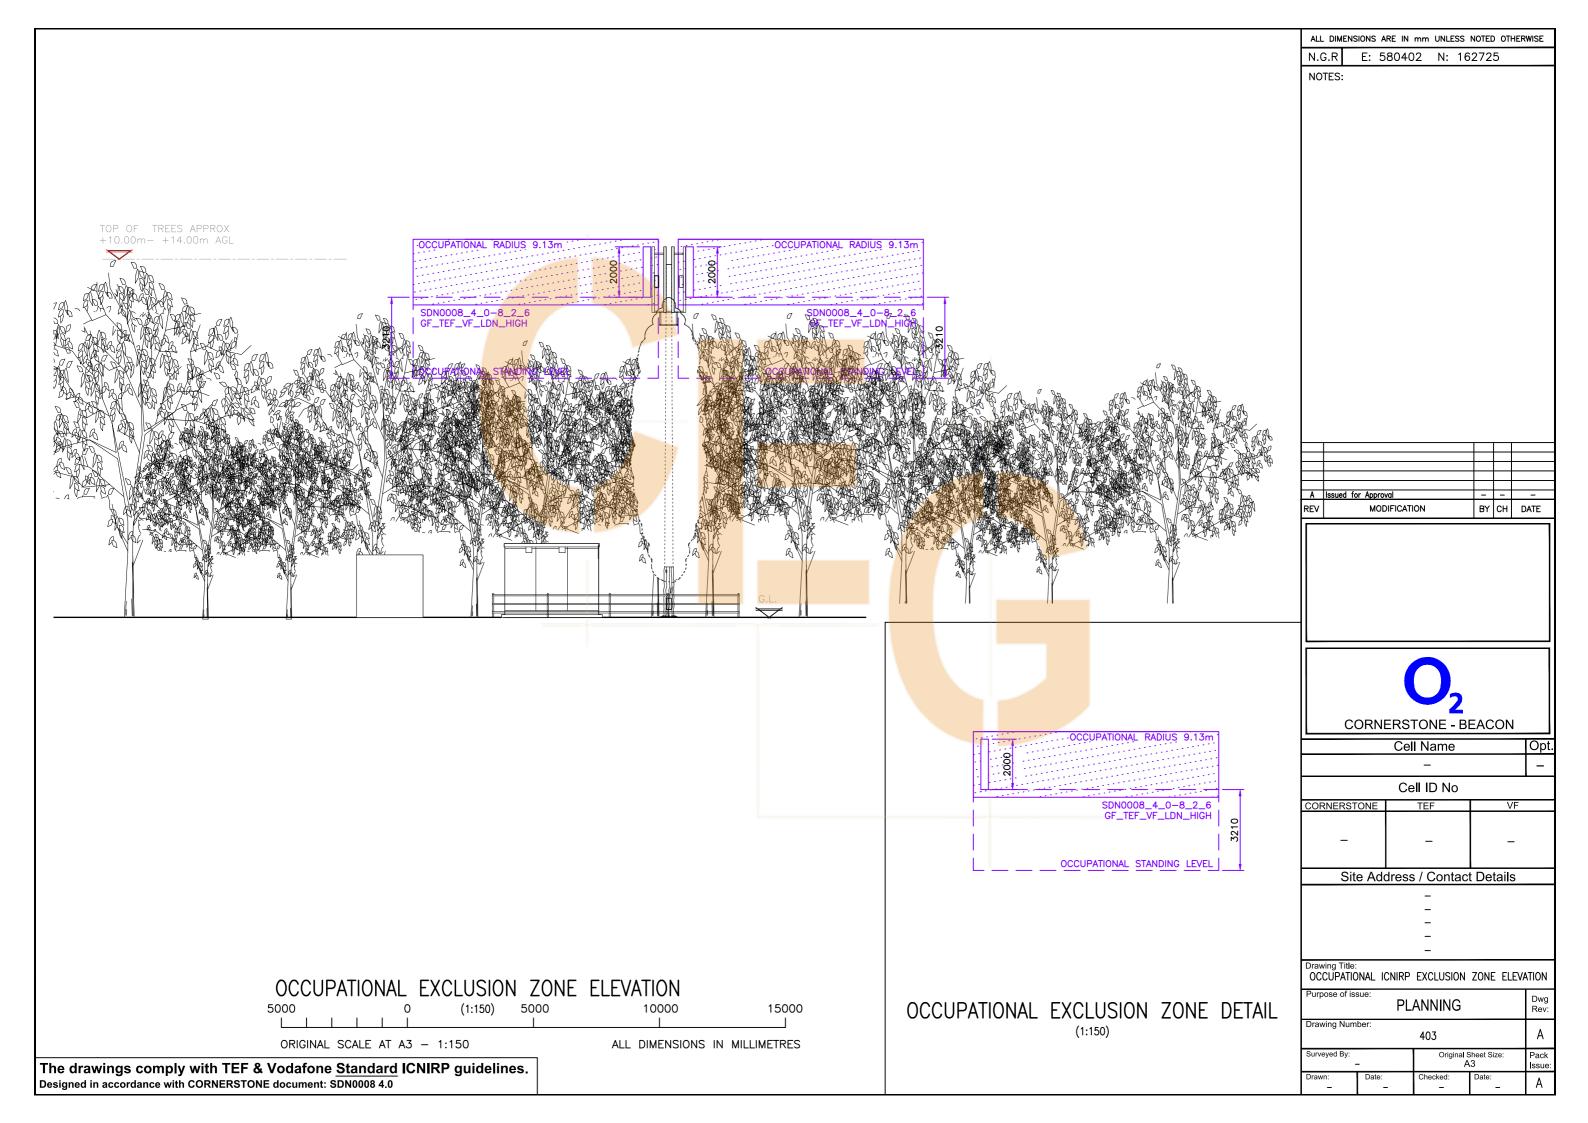


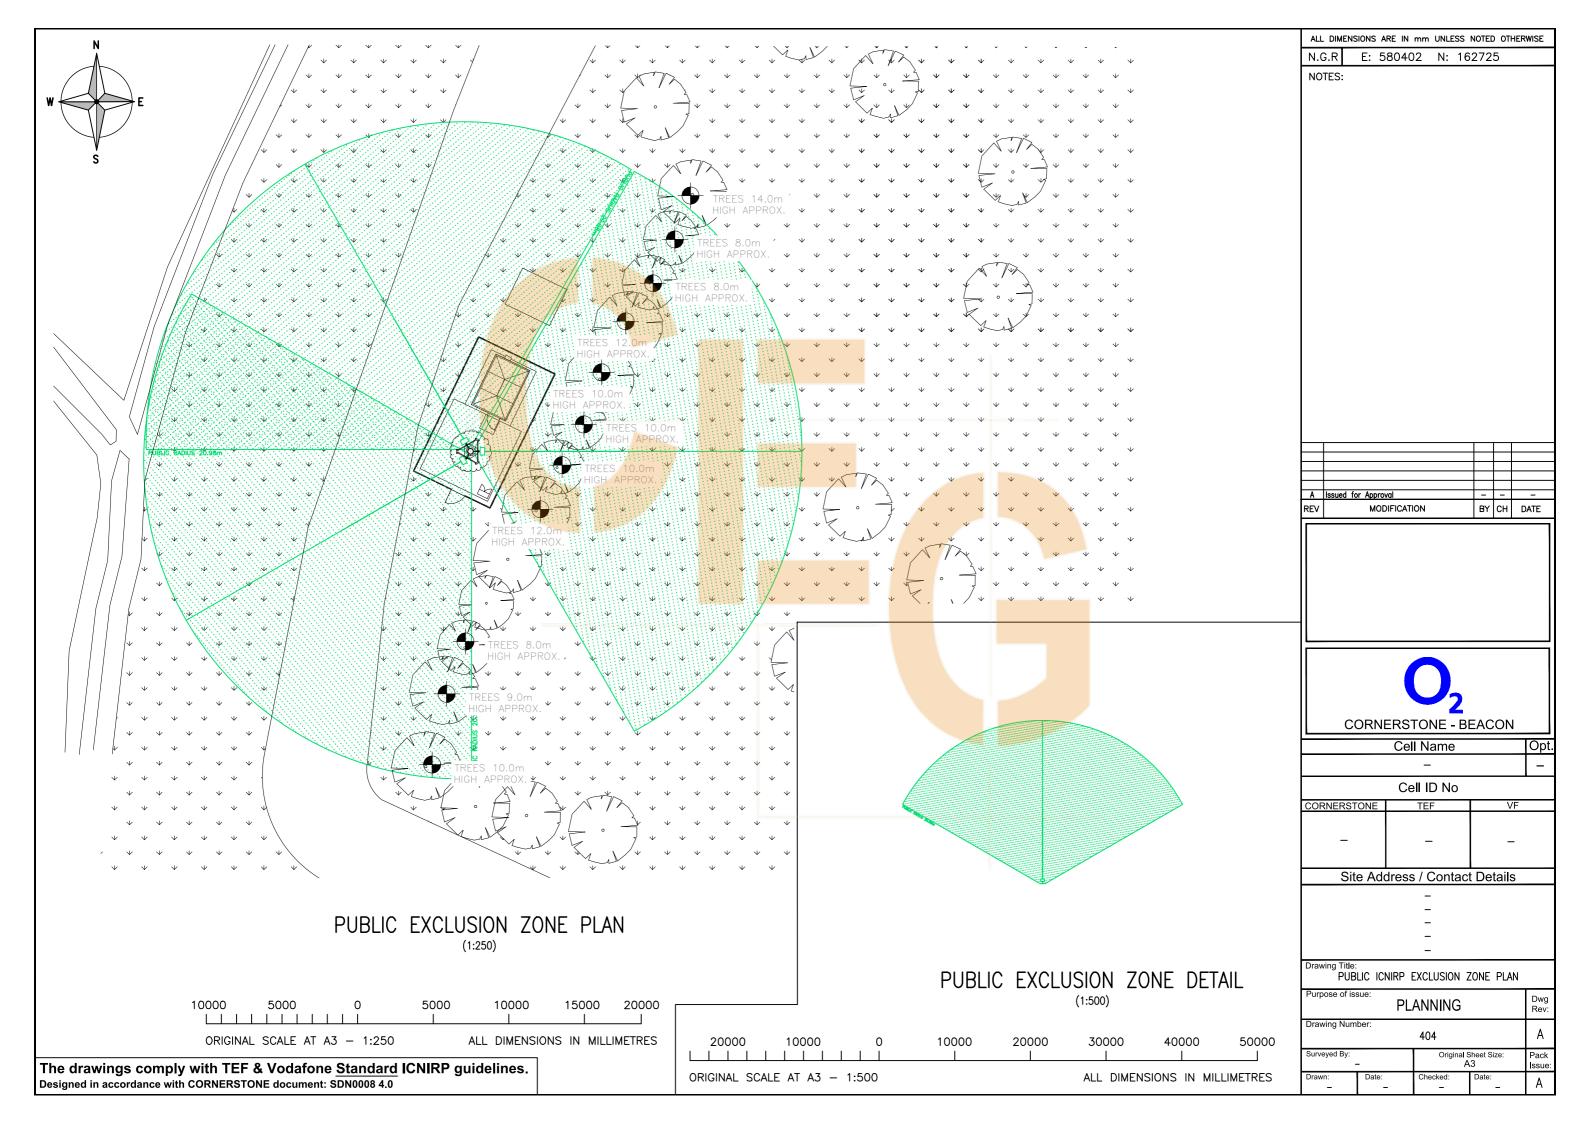

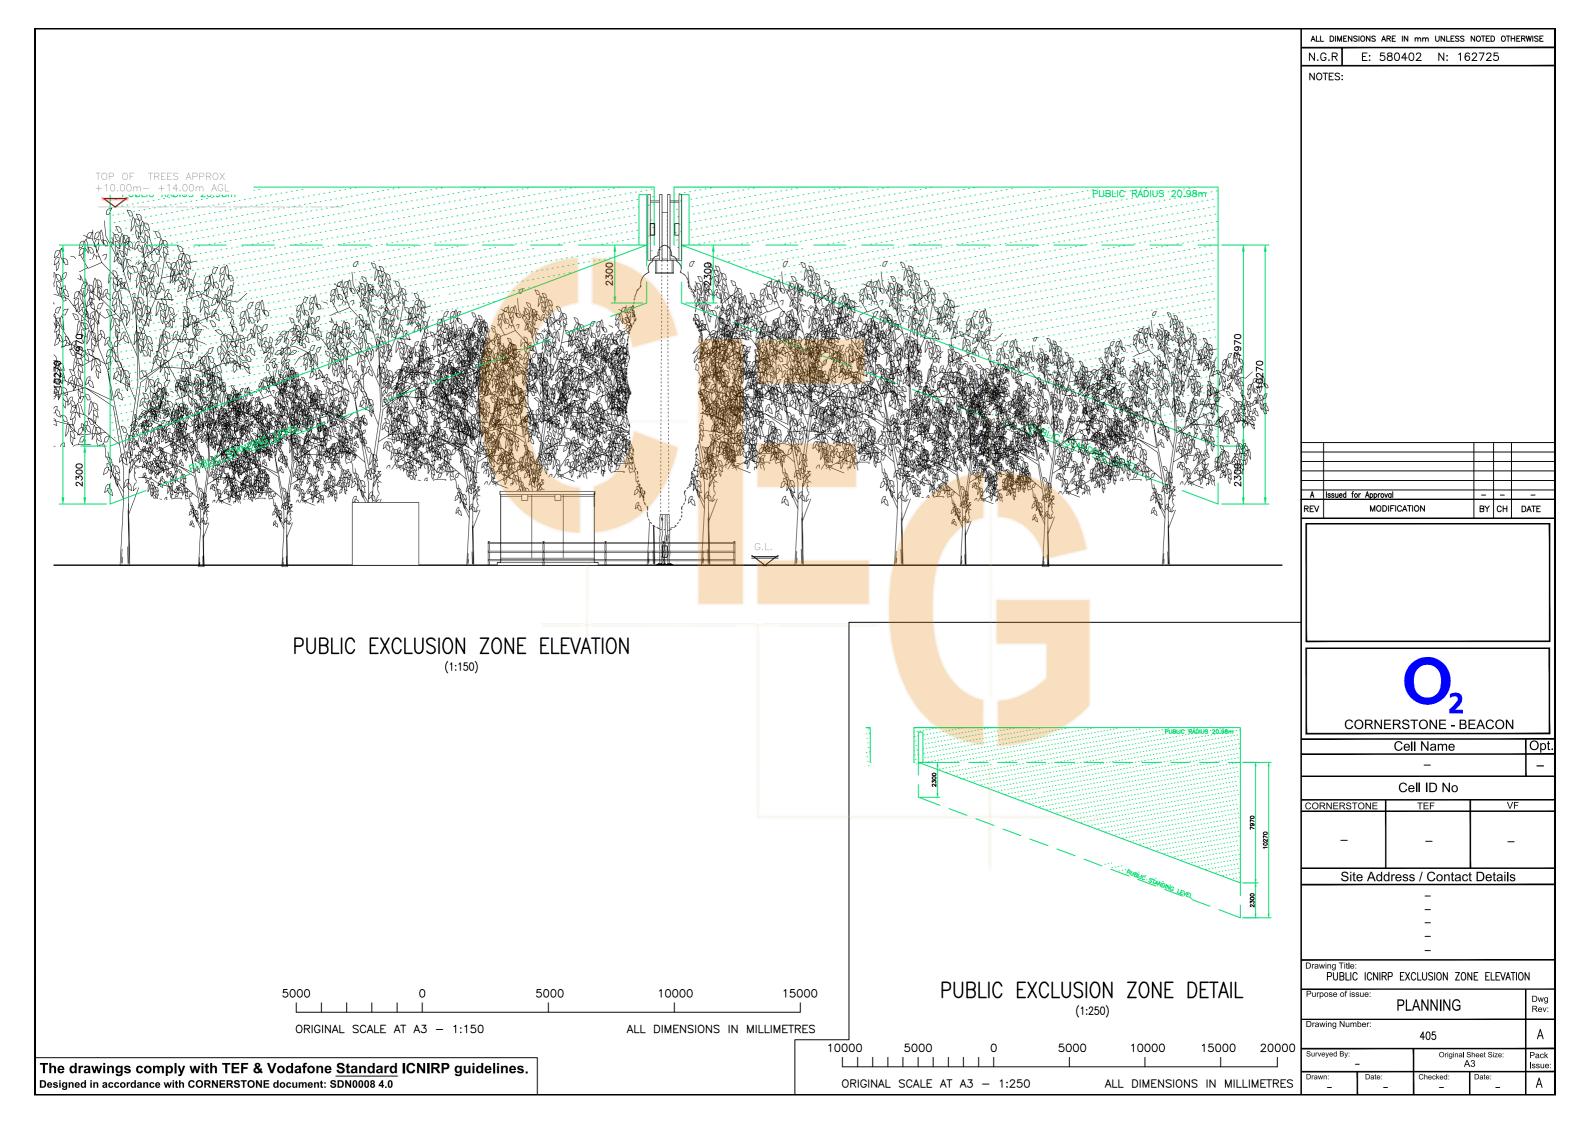

														F	-XISTIN(ANTFNNA	SCHEDULE										N.G.R E:		
																			1								- I	580402 N: 16	
.¥AS						FE	EDER/	/FIBRE					BIAS		s/RRU'		S/COMBINERS	S 				AN	TENNAS	5			_	N CONCESSION	
POSED & ANTENNAS		NO		ENGTH(m	ı) & DI.	IAMETER	٠	TYPE (COAX	FEEDERS QTY	s ,	. 등	BIAS T QTY	MHA QTY	MHA TO ANTENNA JUMPER	RRU QTY	RRU TO ANTENNA JUMPER	LOW LEVEL COMBINER	HIGH LEVEL COMBINER	. ANT. REF.	ANTENNA MANUFACTURERS	BRG* HE	IGHT HEIGH	HEIGHT	LOCATION (POLE MOUNTED	STATUS	COMMENTS	No. DE	SCRIPTION OF CONCESSION	REQUIRED
PROPO:	OPERATO	FUNCT	(SEE	GUIDANO	CE NOT	ES BEL	.OW)	OR FIBRE)	Q 11	RF OTY		Q I I	Q 11	LENGTH (m)	Q11	LENGTH (m)	TYPE (ADJ. TO	TYPE (ADJ. TO	INCI.	PART No.	Т	TOP C/L (m) (m)	U/S	` HEADFRAME, WITHIN SHROUD				CONCESSION NUMBER	APPROVAL DATE
EXIST			MF1	MF(J1) MF([J2) T	JATC		EX'TNG PR	SOP REP	FIBRE			(R'TOPS & G'FIELDS)		(MAX. LENGTH AS PER TEF/VF SPEC)	RADIO EQUIPMENT)	ANTENNA)						ETC)			NOTES:	_	_
	TEF/VF TEF/VF	1U09	√8"=22r	m ½"=3m	n _	- 2	25m	COAX	2	- -	_	1	-	_	-	_	-	L08/U09 COMBINER	EA1a	AMPHENOL									
ISTING	TEF/VF	1GU09	9 %"=221	m ½"=3n	n –	- 2	25m	COAX	2			-	-	-	_	-	-	-	EA1b	_ U-CODE:	90° 14	4.70 13.70	12.70	HEADFRAME	REMAIN				
	TEF/VF			 m ½"=3m	n –		- 25m	- COAX	2	_ _		_	_			_	_	U21 MRC	EA1c EA1d	-									
	TEF/VF	21100	1		_	_	25m	COAX				1						L08/U09	EA2a										
9	TEF/VF			m ½"=3n	_				2	- -				-	_		-	COMBINER		AMPHENOL 50632000	0.40*		07.00	UEADEDANE	DEMIN				
EXISTI	TEF/VF TEF/VF		_	m ½"=3n	n –		25m	COAX	-	_ _		-/	_		-	-	_	_	EA2b EA2c	Q-CODE:	240 26	0.50 25.20	23.90	HEADFRAME	REMAIN				
	TEF/VF	2U21	1 1/8"=221	m ½"=3n	n –	- 2	25m	COAX	2			-	- /	-	-	-	-	U21 MRC	EA2d										
	TEF/VF TEF/VF	3U09	} - 7⁄8"=22r	m ½"=3n	n		25m	COAX	2	_ _	. _	1	-	_	_ \	_	-	L08/U09 COMBINER	EA2a	AMPHENOL									
STING	TEF/VF			m ½"=3n		- 2	25m	COAX	2	_	-	_	_	_	_	_	_	-	EA2b	50632000	330° 26	6.50 25.20	23.90	HEADFRAME	REMAIN				
	TEF/VF			-	_		-	-		- -		-	-	-	-	-	-	-	EA2c	TB65DDWW20J8									
	TEF/VF	3U21	1 /8"=22r	m ½"=3n	n –		25m	COAX	2	_ _		-		_		_	-	U21 MRC	EA2d										
																											A Issued for App	oroval ODIFICATION	
																											REV M	DERSTONE - BI Cell Name - Cell ID No	BY CH DA
																											CORNERSTONE	DERSTONE - BI Cell Name - Cell ID No	EACON VF
																											CORNERSTONE Site A	DODIFICATION 2 NERSTONE - B Cell Name - Cell ID No TEF - ddress / Contact	EACON VF
OPERA	ATOR &	¢ FUNG	CTION	LEGEN	D				FE	 EDER,		E LEGE	END				BIAS T's	s/MHA's/R	RRU's/	/JUMPER/COMBI	NERS I	LEGEND			ANTEN	NA LEGEND	CORNERSTONE Site A	DODIFICATION 2 NERSTONE - B Cell Name - Cell ID No TEF - ddress / Contact STING ANTENNA SCH	EACON VF The state of the sta
= T	ELEFONIC	CA	CTION	LEGEN		MF1			EDER LEN	NGTH ((INCLUI	DING P	RE-RIC	GGED IN S		JMN) BIAS		No. OF	BIAS T	Γ's FOR GIVEN TEC	CHNOLO	GY			DESIGNAT	ION (A-Z)	CORNERSTONE CORNERSTONE Site A Drawing Title: EXIS Purpose of issue:	DODIFICATION 2 NERSTONE - B Cell Name - Cell ID No TEF - ddress / Contact	EACON VF The state of the sta
= T	ELEFONIC ODAFONE	CA E		LEGENI		MF(J1) = N	MAIN FEI	EDER LEN	NGTH ((INCLUI	DING P	RE-RIC	VEL COMB	BINERS)	MHA	S T =	No. OF I	BIAS T	T's FOR GIVEN TECHN	CHNOLO	GY,		1 =	DESIGNAT	ION (A-Z)	CORNERSTONE Site A Drawing Title: EXIS	DODIFICATION 2 NERSTONE - B Cell Name - Cell ID No TEF - ddress / Contact STING ANTENNA SCH	EACON C
= T = V = S	ELEFONIC	CA E (2,3 et	cc)) = N	MAIN FEI MAIN FEI	EDER LEN	NGTH (MPER MPER	(INCLUI 1 LEN	DING P	RE-RIC		BINERS)	MHA	S T = A JUMPER =	No. OF E No. OF I	BIAS T MHA's LENGT	Γ's FOR GIVEN TEC	CHNOLO NOLOGY & MAIN	OGY , N FEEDER	₹	1 = b =	DESIGNATI SECTOR (PORT REF	ION (A-Z)	CORNERSTONE CORNERSTONE Site A Drawing Title: EXIS Purpose of issue: Drawing Number: Surveyed By:	DOIFICATION PLANNING SOU Original S Original S Original S Original S Original S	EACON VF - t Details

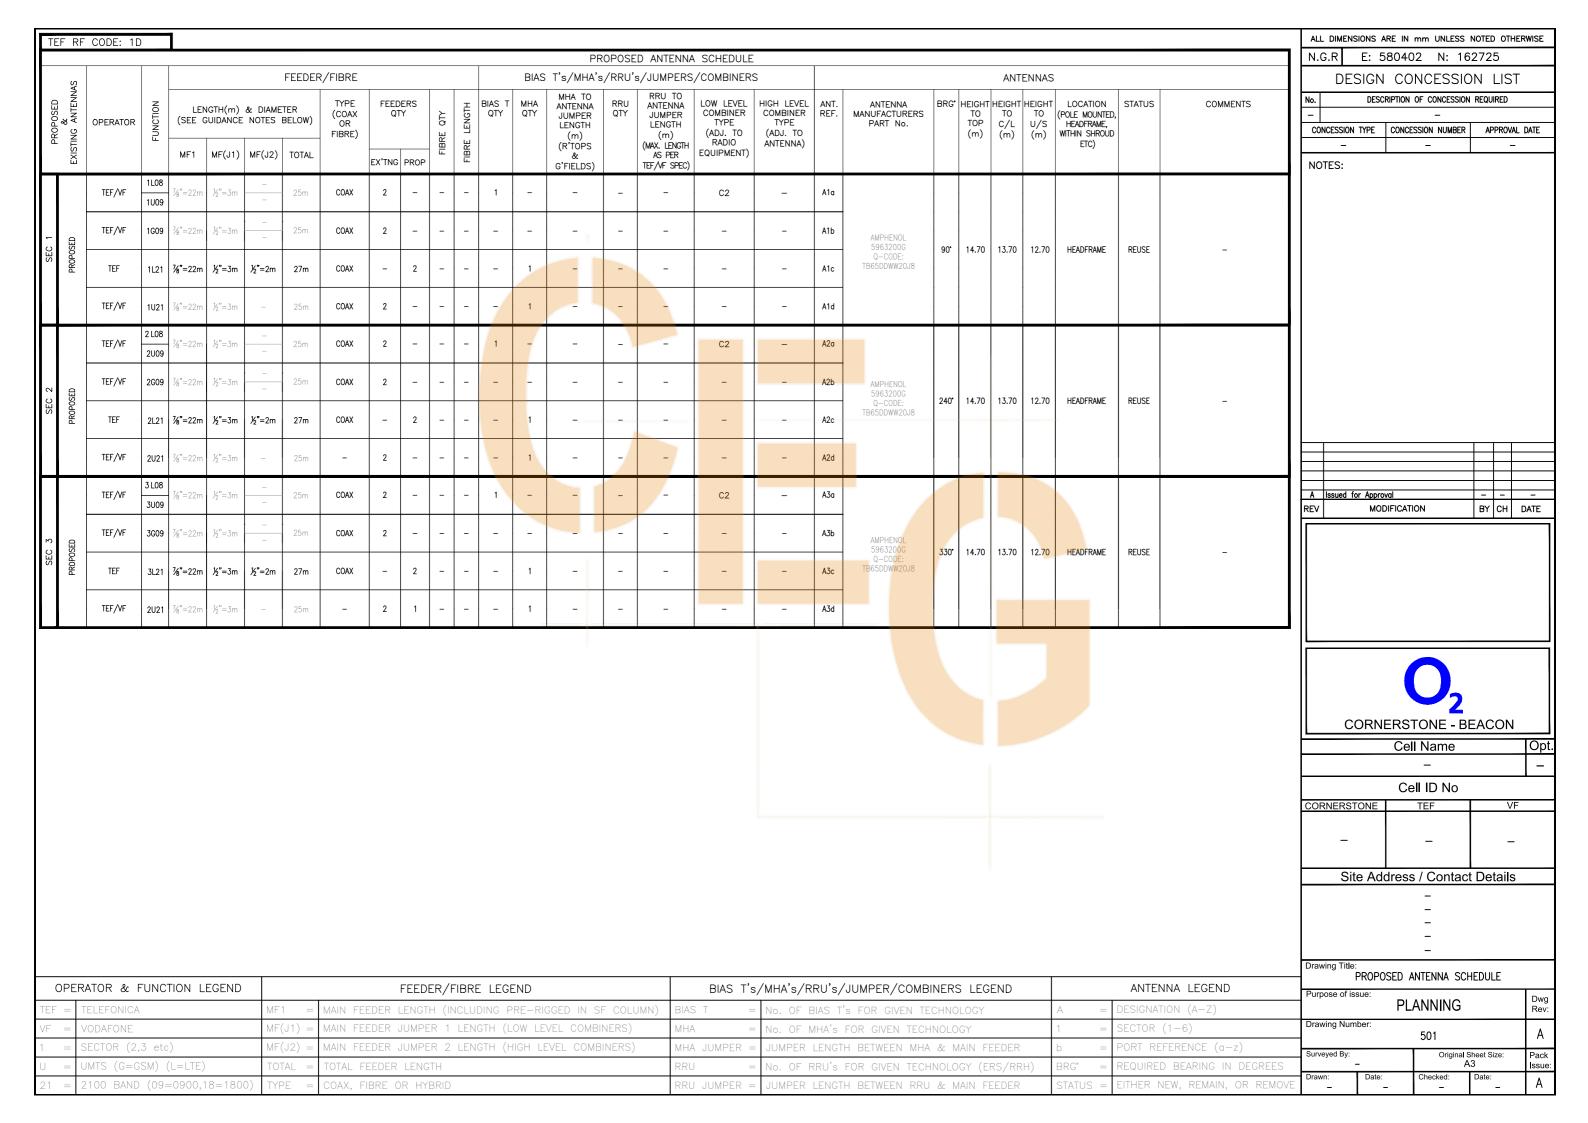

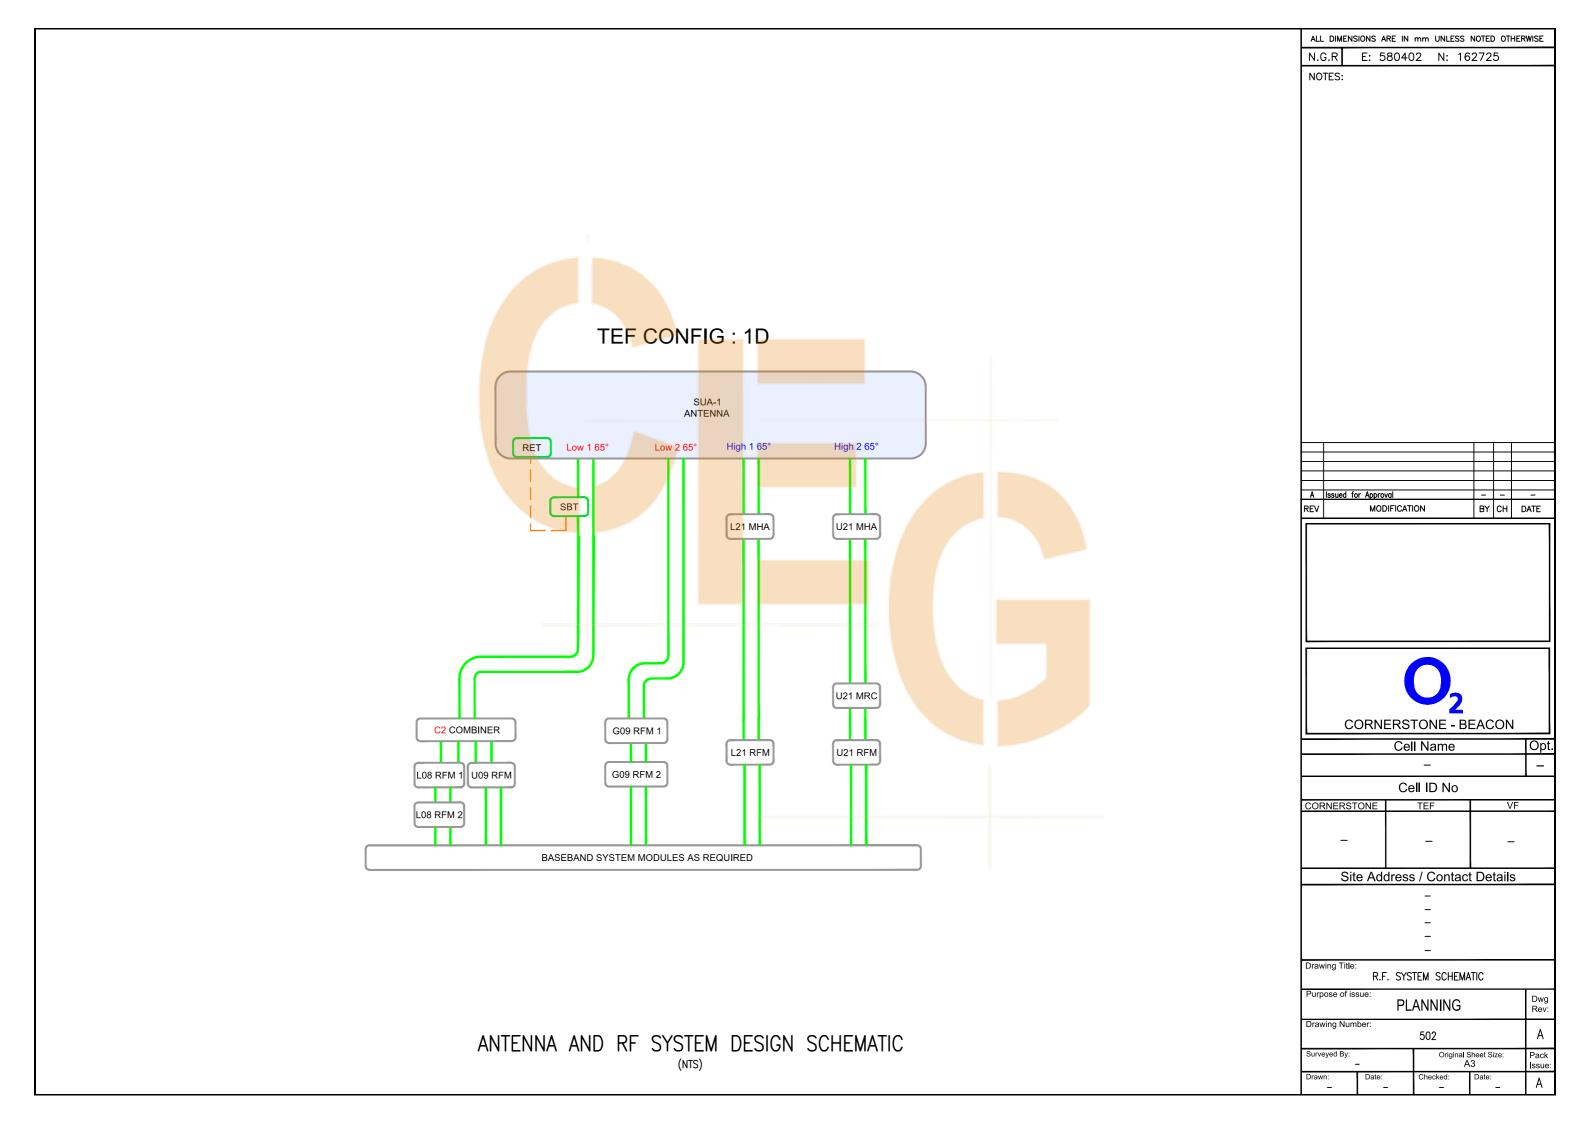

	SUPPORT STRUCTURE SCHEDULE												
EXISTING/ PROPOSED	OPERATOR	MANUFACTURER	MODEL	STRUCTURE HEIGHT	FOUNDATION TYPE (ROOT/PAD/GRILLAGE)	FOUNDATION DIMENSIONS (WxDxH)	COLOUR/ FINISH	STATUS	COMMENTS				
EXISTING	TEF/VF	FLI	CYPRESS TREE	15.0m	PAD	43001mmx4300mm	GREEN	REMAIN	_				
EXISTING	TEF/VF	_	YOKE BRACKETS	-	_	_	GREEN	REMAIN	_				

	ENCLOSURE SCHEDULE												
EXISTING/ PROPOSED	OPERATOR	MANUFACTURER	MODEL	DIMENSIONS (WxDxH)	LOCATION	COLOUR/ FINISH	STATUS	COMMENTS					
EXISTING	TEF/VF	_	EQUIPMENT CABIN	_	_	GREEN	REMAIN	-					
EXISTING	TEF	NSN	FLEXI RACK	603x603x1787	_	GREY	REMAIN	_					
EXISTING	TEF	NSN	FLEXI RACK	603x603x1787	_	GREY	REMAIN	_					
EXISTING	TEF	ELTEK	4th GEN PSU ID	700x820x1800	-	GREY	REMAIN	_					

				RF EQUIPI	MENT SCHEDULE				
EXISTING/ PROPOSED	OPERATOR	MANUFACTURER	MODEL	DIMENSIONS (WxDxH)	LOCATION	QUANTITY	COLOUR/ FINISH	STATUS	COMMENTS
EXISTING	TEF/VF	NOKIA	FLEXI GU09 FXDB	490x560x133	FLEXI RACK	1	GREY	REMAIN	_
EXISTING	TEF/VF	NOKIA	FLEXI G09 ESMB	490x560x133	FLEXI RACK	1	GREY	REMAIN	-
EXISTING	TEF/VF	NOKIA	FLEXI U09 FSME	490x560x133	FLEXI RACK	1	GREY	REMAIN	-
EXISTING	TEF/VF	NOKIA	FLEXI LO8 FRMA 2	490x560x133	FLEXI RACK	1	GREY	REMAIN	_
EXISTING	TEF/VF	NOKIA	FLEXI LO8 FRMA 1	490x560x133	FLEXI RACK	11	GREY	REMAIN	_
EXISTING	TEF/VF	NOKIA	FLEXI LO8 FSMF	490x560x133	FLEXI RACK	1	GREY	REMAIN	_
EXISTING	TEF/VF	RD/COMMSCOPE	C2 COMBINER	_	FLEXI RACK	3	GREY	REMAIN	L08/U09 MODULE
EXISTING	TEF/VF	_	U21 MRC	_	FLEXI RACK	3	GREY	REMAIN	U21 MODULE
EXISTING	TEF/VF	_	21 MHA	_	HEADFRAME	3	GREY	REMAIN	-
EXISTING	TEF/VF	NOKIA	FLEXI U21 FRGT	490x560x133	FLEXI RACK	1	GREY	REMAIN	_
EXISTING	TEF/VF	NOKIA	FLEXI U21 FSME	490x560x133	FLEXI RACK	1	GREY	REMAIN	-
PROPOSED	TEF	AIRSCALE	AMIA	447x128x400 (3U)	FLEXI RACK	1	GREY	NEW	4G
PROPOSED	TEF	NOKIA	FLEXI FRGU	447x400x128	FLEXI RACK	1	GREY	NEW	L21
PROPOSED	TEF	-	21 MHA	-	HEADFRAME	3	GREY	NEW	-

	AC POWER SUPPLY SCHEDULE										
EXISTING/ PROPOSED	OPERATOR	MANUFACTURER	MODEL	SUPPLY TYPE (DNO/LL)	PHASE (SINGLE/THREE)	SUPPLY RATING (AMPS)	EARTHING (TN-C-S/TT)	COMMENTS			
PORTASTOR	VF	PORTASTOR	METER CABINET	DNO	THREE	100A	TN-C-S	_			

		DC POWER SUPPLY UNIT SCHEDULE									
	EXISTING/ PROPOSED	OPERATOR	MANUFACTURER	MODEL	LOCATION	AC SUPPLY TO PSU BREAKER SIZE (AMPS)	RECTIFIER SIZE (kW)	RECTIFIER QUANTITY	UPGRADE REQUIRED (Y/N)		COMMENTS
Γ	EXISTING	TEF	ELTEK	4th GEN PSU ID	CABIN	40A	3	3	N		_

	TRANSMISSION SUPPLY SCHEDULE									
EXISTING/ PROPOSED	OPER	ATOR	TRANSMISSION	TRANSMISSION SOLUTION	CURRENT	PROPOSED TRANSMISSION	COMMENTS			
(ENCLOSURE)	OPOSED FINCLOSLIBE (MICROWAVE ONLY/FIBRE ONLY/ AVAILABLE TRANSMISSION TRANSMISSION									
EXISTING	VF	_								

	COOLING SCHEDULE											
EXISTING/ PROPOSED	OPERATOR	COOLING SYSTEM MANUFACTURER	COOLING SYSTEM MODEL	TYPE (FREE AIR/ PACKAGED/AC)	COOLING CALCULATOR VERSION	COOLING CAPACITY (kW)	SITE HEAT LOAD (kW)	UPGRADE REQUIRED (Y/N)	STATUS	COMMENTS		
EXISTING	VF	ALIFABS	MONITOR 12	FREE AIR	2.20	12kW	5.4	N	_	_		

ALL DIMENS	SIONS ARE IN	mm UNLES	S N	OTE	ОТІ	HER	WISE
N.G.R	E: 5804	02 N:	162	272	5		
DESIGN	DEPE	NDENCIE	<u>ES</u>		CON	1PL	ETE!
STAT SE	EARCH R	ESULTS	Ν	0	XX.	××.	XXX
ASBEST	OS REPO	ORT	N	0	XX.	ΚX.	XXX
RADAR	SCAN RE	PORT	N	0	XX.	ΚX.	XXX
COOLING	G CALCS		V	7	CON	1PL	ETE
LL FIRE	ALARM	ASSESS	N	0	XX.	ΚX.	XXX
GDC	LEVI	EL 1	V	7	RE	QU	IRED
STRUCT	JRAL CA	LCS	V	7	RE	QU	IRED
HD BOL	T GRADE	ETEST	N	0	XX.	ΚX.	XXX
FOUNDA	TION CA	LCS	V	7	RE	QU	IRED
BOREHO	LE REPO	ORT	Ν	0	XX.	ΚX.	XXX
TRIAL H	OLE REF	PORT	Ν	0	XX.	ΚX.	XXX
BOLT P	ULL TES	Т	Ν	0	XX.	ΚX.	XXX
BUILDIN	G REG'S	APP.	N	0	XX.	<Χ.	XXX
NET RAI	L TECH	PACK	N	0	XX.	ΚX.	XXX
DNO QL	JOTE API	PROVAL	N	0	XX.	ΚX.	XXX
GRP AP	PROVAL		N	0	XX.	XX.	XXX)
REFER TO TH	E SITE SPECI	FIC DRAWING	SUE	BMISS	ION	CHE	CKLIST
(SDN0020) FO WHERE TO FIN	D ALL ACCOM	PANYING DESIG	GN D	OCUN	MENTA	TION	in On
A leaved fo							
A Issued fo	MODIFICA	TION		BY	CH	D	ATE
C	ORNERS	TONE -	BE	AC	1O:	l	
	Се	II Name					Op
							_
	С	ell ID No					
CORNERST	ONE	TEF	I		٧	F	
_		_			-	-	
Sit	e Addres	s / Conta	act	De	tails	3	
		-					
		_					
		_					
		_					
Drawing Title:		MENT SCHE	ווו	 F			
Purpose of is:	sue:			_		_	
6000 01 10	Pl	ANNING	;				Dwg Rev:
Drawing Num	ber:	F07					٨
0 :-		503					A
Surveyed By:	-	Origin	al Sh A3		ize:		Pack Issue
Drawn:	Date:	Checked:	T	Date:	_		Α
_	ı						